



MAIN LEVEL WATER FLOOR PLAN

SCALE: 1/8" = 1'-0"

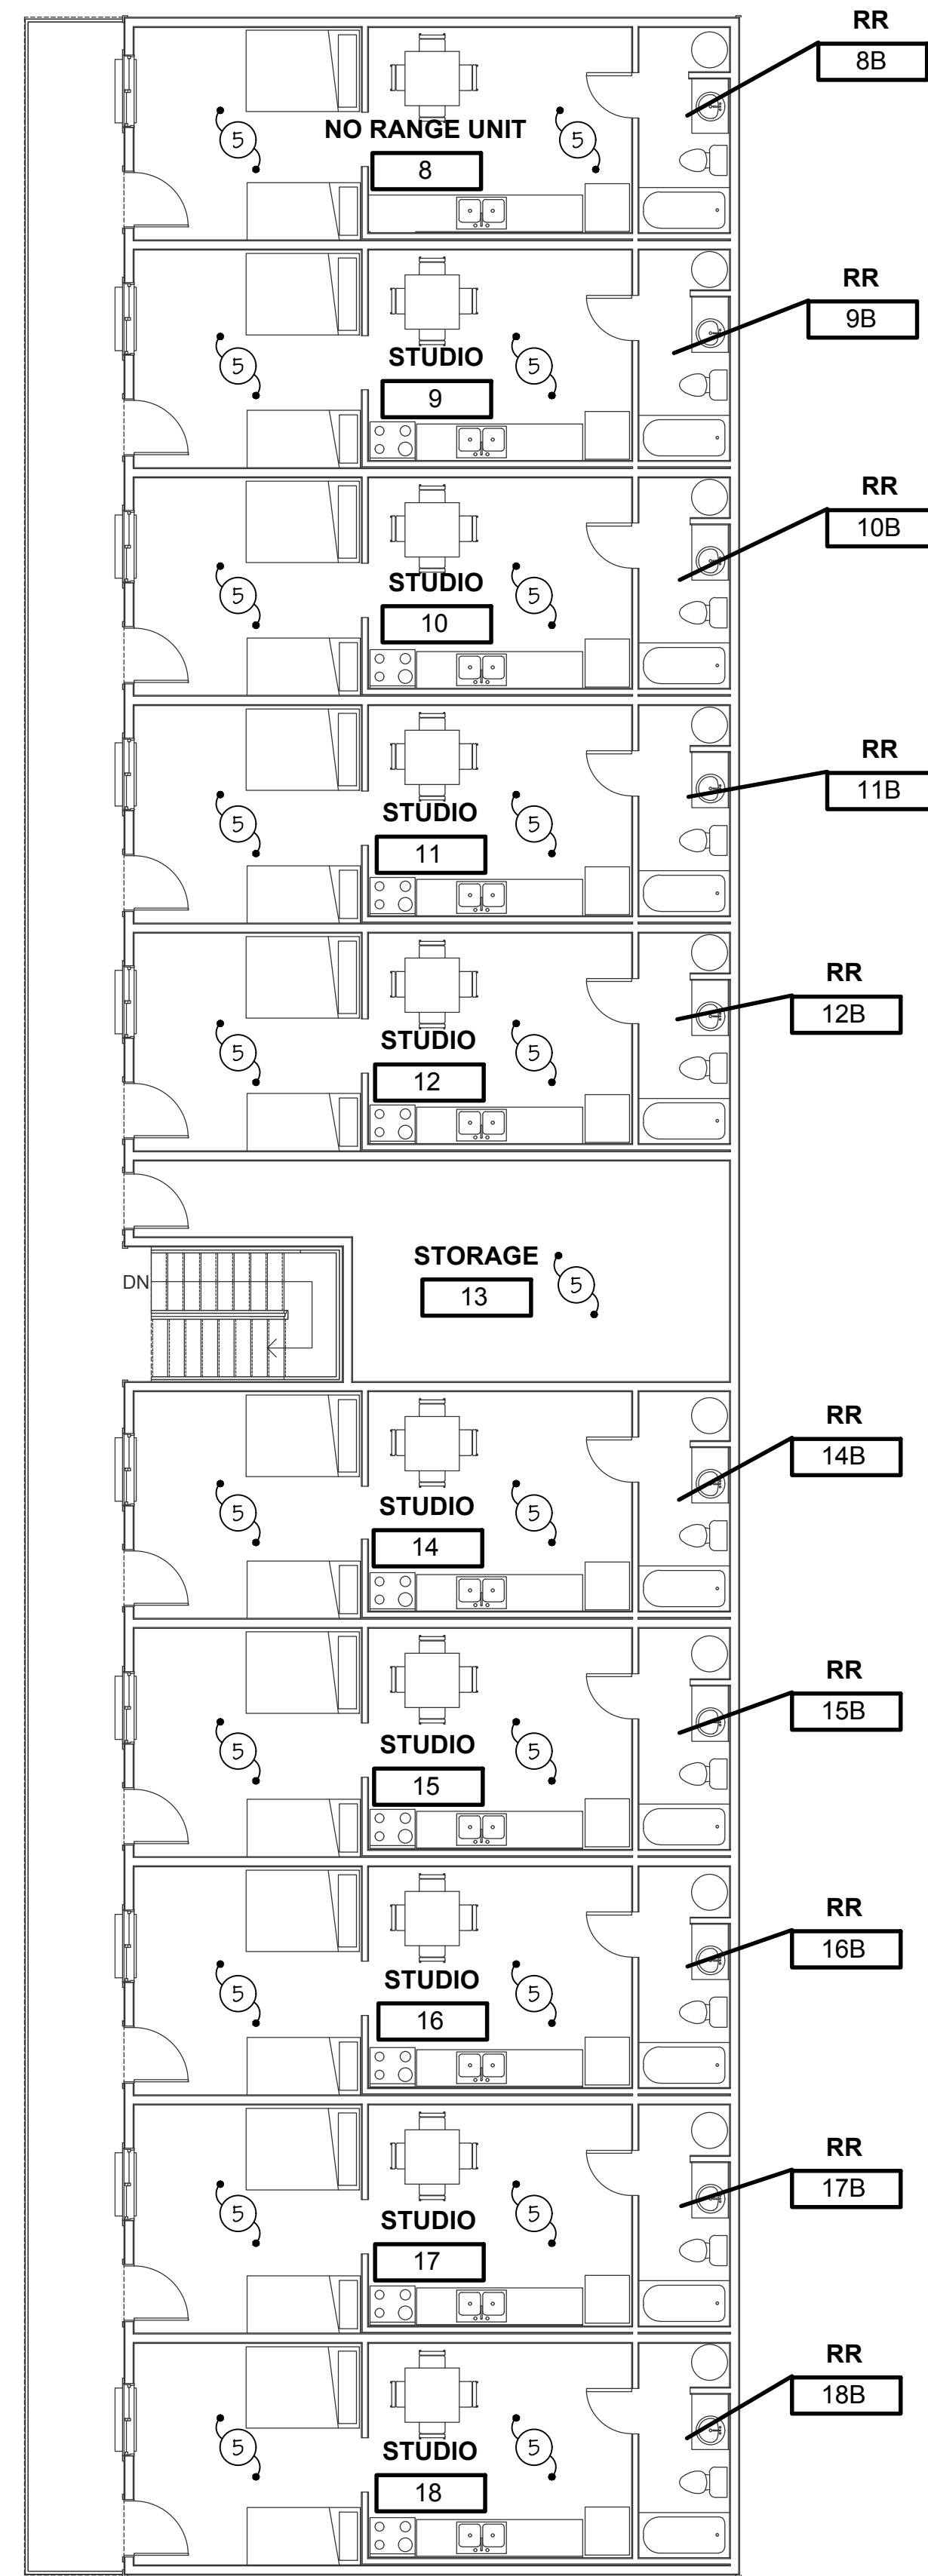



SECOND LEVEL WATER FLOOR PLAN

SCALE: 1/8" = 1'-0"

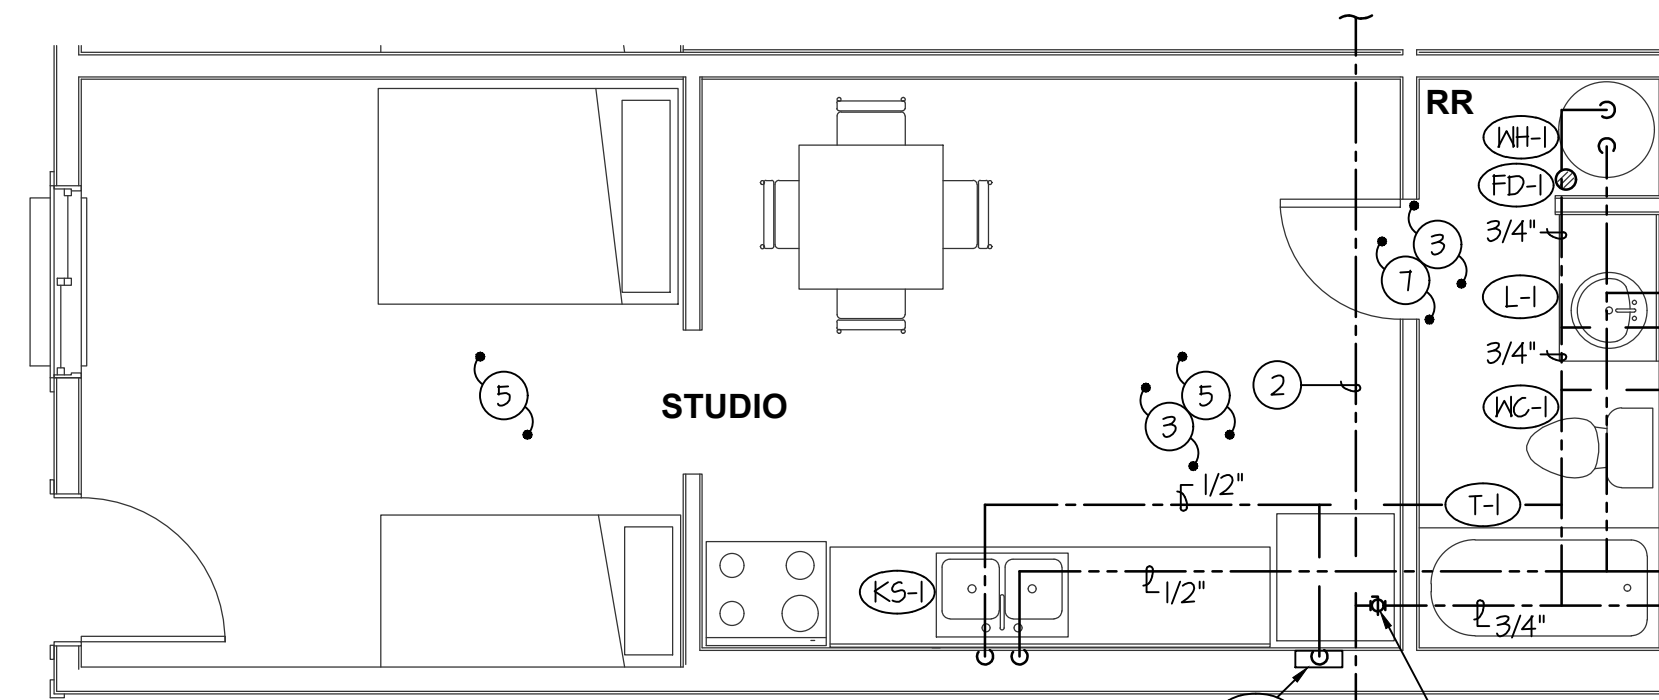


SECOND LEVEL TYP. WATER FLOOR PLAN

SCALE: 1/4" = 1'-0"

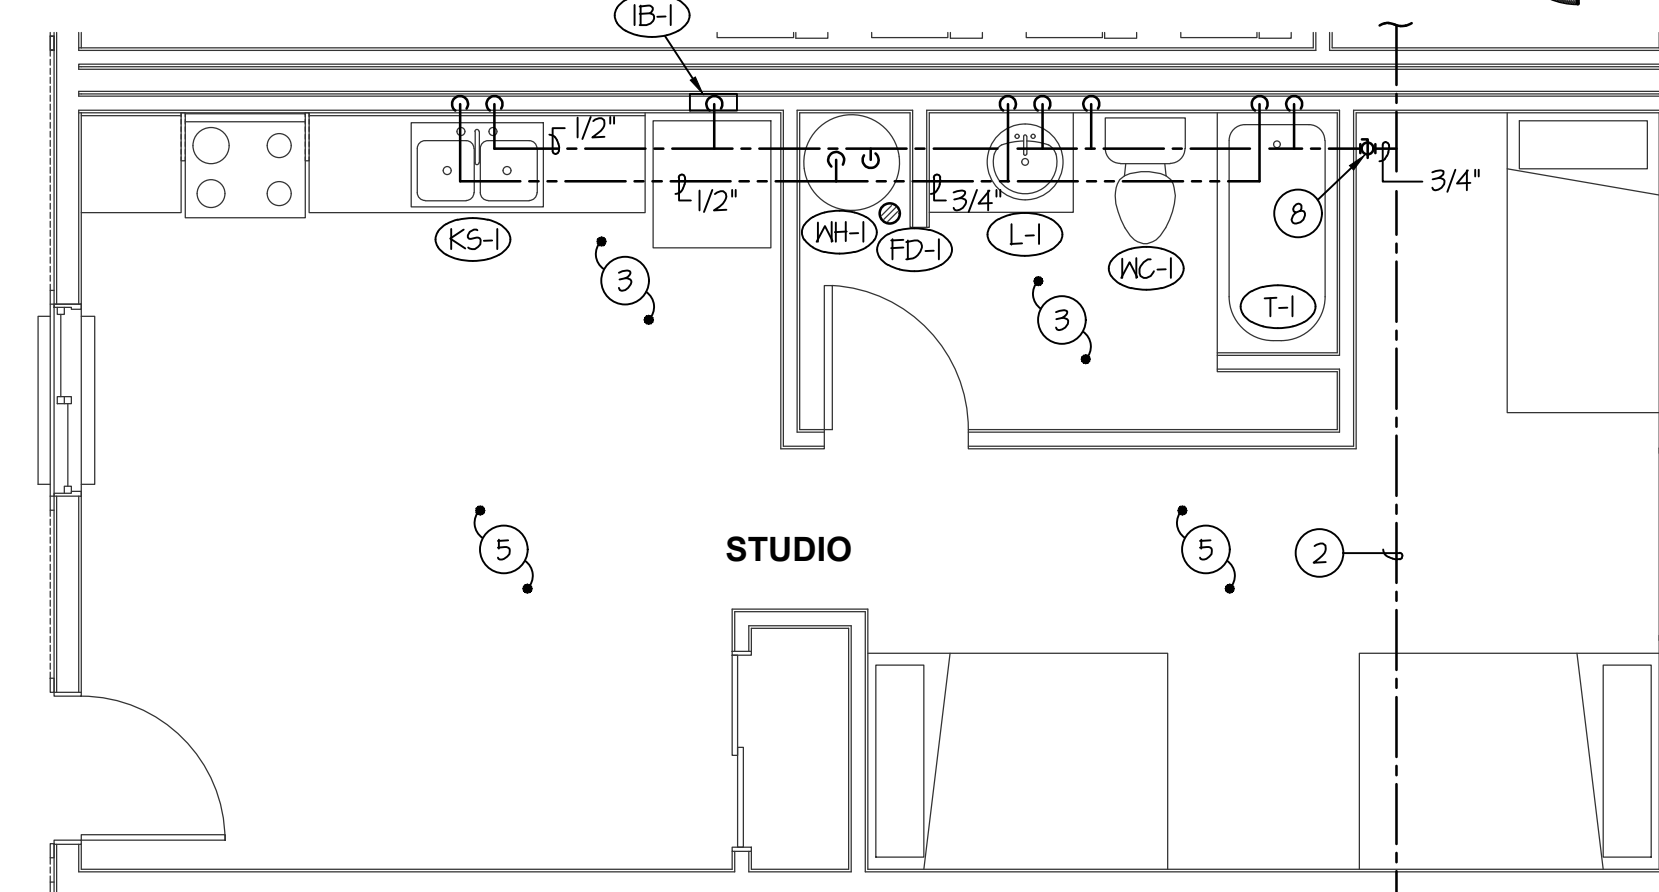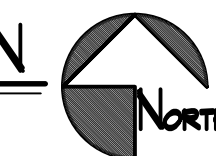



MAIN LEVEL TYP. WATER FLOOR PLAN

SCALE: 1/4" = 1'-0"

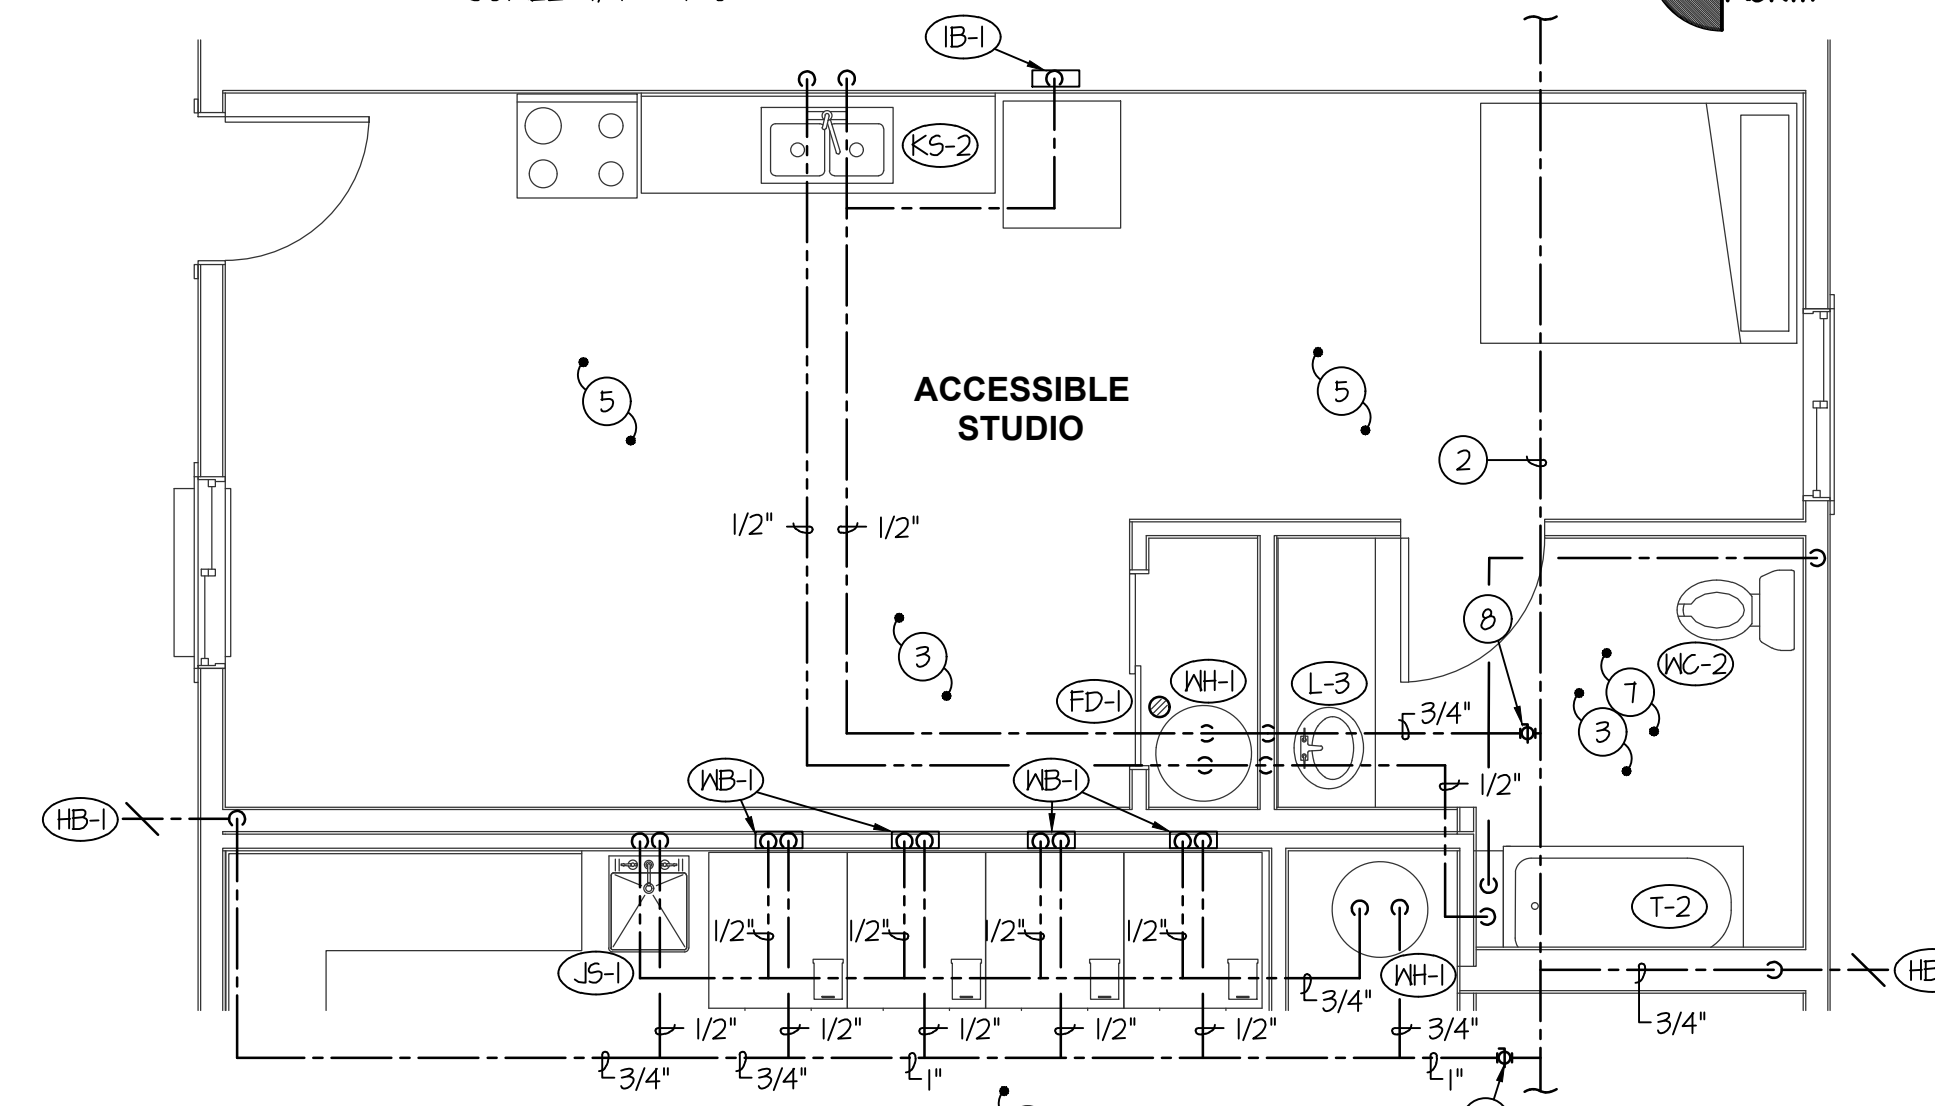


MAIN LEVEL ADA WATER FLOOR PLAN

SCALE: 1/4" = 1'-0"

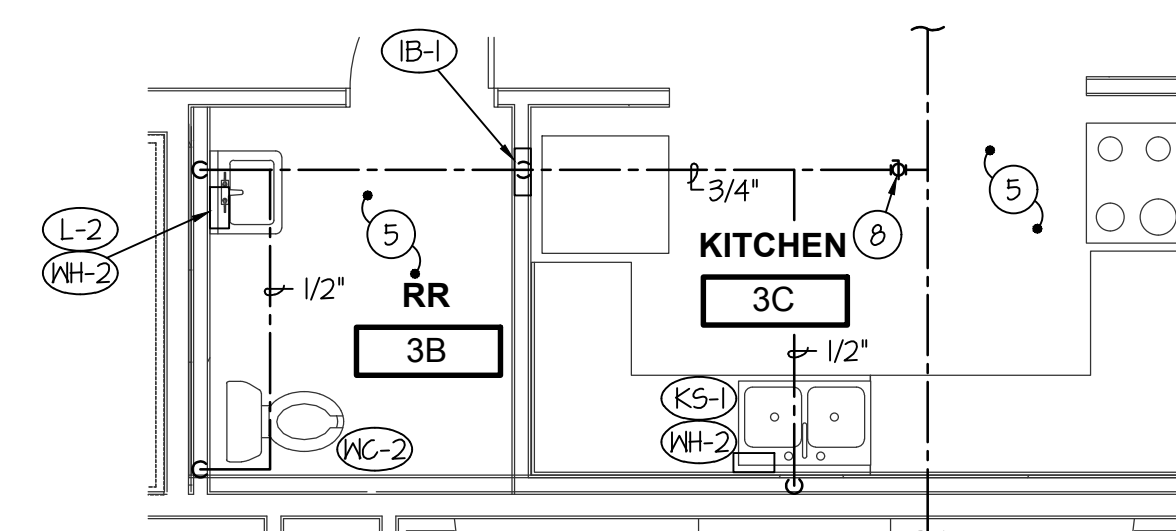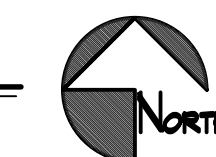

MAIN LEVEL GATHERING WATER FLOOR PLAN

SCALE: 1/4" = 1'-0"

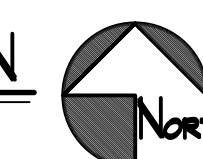

PLAN NOTES:


- 1 2" WATER LINE UNDER SLAB TO BE CONTINUOUS WITH NO JOINTS OR ELBOWS.
- 2 SEE THIS SHEET FOR SIZES.
- 3 SEE PLUMBING SCHEDULE FOR BRANCH LINE SIZES NOT INDICATED ON PLANS.
- 4 SEE FIRE RISER DETAIL ON SHEET P2-1.
- 5 INSTALL COMPLETE FIRE SPRINKLER SYSTEM THROUGHOUT BUILDING AS PER NFPA 13-R REQUIREMENTS.
- 6 SEE PRV DETAILS ON SHEET P2-1.
- 7 SEE OUTSIDE PIPING IN OUTSIDE WALL DETAIL ON SHEET P2-0.
- 8 PROVIDE AND INSTALL ISOLATION VALVE FOR EACH REGION WITH ACCESS BOX.

NOTE

ALL WATER PIPING TO BE RUN IN BETWEEN MAIN & 2ND LEVEL CEILING SPACE FOR BOTH LEVELS.

PLUMBING LEGEND

SYMBOL	DESCRIPTION
V	VENT
VTR	VENT THRU ROOF
CO	CLEANOUT
WCO	WALL CLEANOUT
COTG	CLEANOUT TO GRADE
e	PIPE DROP
o	PIPE RISE
⊕	BALL TYPE ISOLATION VALVE
---	SOIL OR WASTE PIPING
---	VENT LINE PIPING
---	DOMESTIC COLD WATER PIPING
F	FIRE SPRINKLER LINE
---	DOMESTIC HOT WATER PIPING
G	GAS PIPING
CD	CONDENSATE DRAIN PIPING

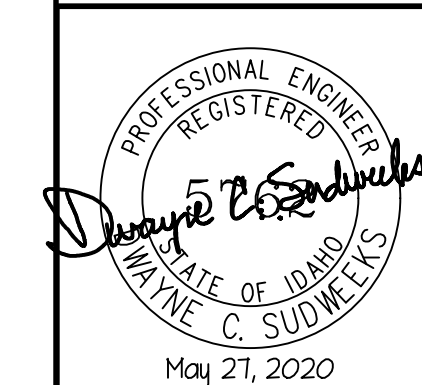

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DATE: _____
 Drawn: _____
 Checked: _____
P1-1